GENERAL NOTES

DOCUMENTS

1. SEE DRAWING NO. 1 FOR GENERAL NOTES.


CONCRETE NOTES:

1. ALL CONCRETE SHALL BE 150lbs. PER CUBIC FOOT DENSITY AND SHALL ATTAIN A MINIMUM COMPRESSIVE STRENGTH OF 3000psi

- 2. ALL SLABS SHALL HAVE 4" THICK CONCRETE WITH 6X6 #6 WIRE MESH OR #3 BARS 24" ON CENTER EACH WAY. ALL SLABS TO HAVE A 6 MIL. WATERPROOF MEMBRANE OVER BONDED TERMITE TREATMENT.
- 3. FOOTING SHALL BE A MINIMUM OF 12 INCHES BELOW NATURAL UNDISTURBED SOIL PER IRC: 403.1.4
- 4. FOOTING SHALL BE REINFORCED WITH 2 #5 BARS EACH WAY 24" ON CENTER. REINFORCING SHALL BE PLACED 3" FROM THE BOTTOM
- 5. OVERLAP ALL REBARS 36 BAR DIAMERERS, MINIMUM.
- 6. BTM PLATES SHAL BE ANCHORED WITH 5/8"x10" LG. ANCHOR BOLT, W/3" LEG, SPACED 24" O.C., AND SHALL HAVE A 3" SQ. FLAT WASHER WITH HEX NUT.
- 7. RIVER SAND OVER COMPACTED BASE SHALL BE USED WITH ALL FILL COMPACTED TO 95% MAX. SOIL DENSITY.
- . ALL AREAS WITHIN THE FOUNDATION WALLS SHALL BE CLEARED FREE OF ALL VEGITATION, TOP SOIL & FOREIGN MATTER PER IRC 506.2
- 9. OWNER OR HIS AGENT IS RESPONSIBLE FOR FINAL DESIGN OF FOUNDATION AND INVESTIGATION OF EXISTING SOIL BEARING CONDITIONS.


MASONRY


- . MASONRY SHALL BE CONSTRUCTED IN ACORDANCE WITH THE LATEST GUIDELINES OF THE BRICK NSTITUTE OF AMERICA.
- 2. HORIZONTAL REINFORCMENT SHALL BE AT ALL INTERSECTIONS A MINIMUM 9 GUAGE CORRUGATED WALL TIES GALVANIZED AND EXTENDING A MINIMUM OF 24" IN EACH DIRECTION.
- 3. MASONRY OVER ALL OPENINGS SHALL BE SUPPORTED BY STEEL LINTELS.
- 4. PLATE ANCHORS SHALL BE NO MORE THAN 6" FROM THE END OF PLATE AND NO MORE THAN 6" ON CENTER. ANCHOR SHALL BE EMBEDED IN NO LESS THAN 4" CONCRETE, WELDED OR HOOKED TO THE BOND REINFORCING BEAM.

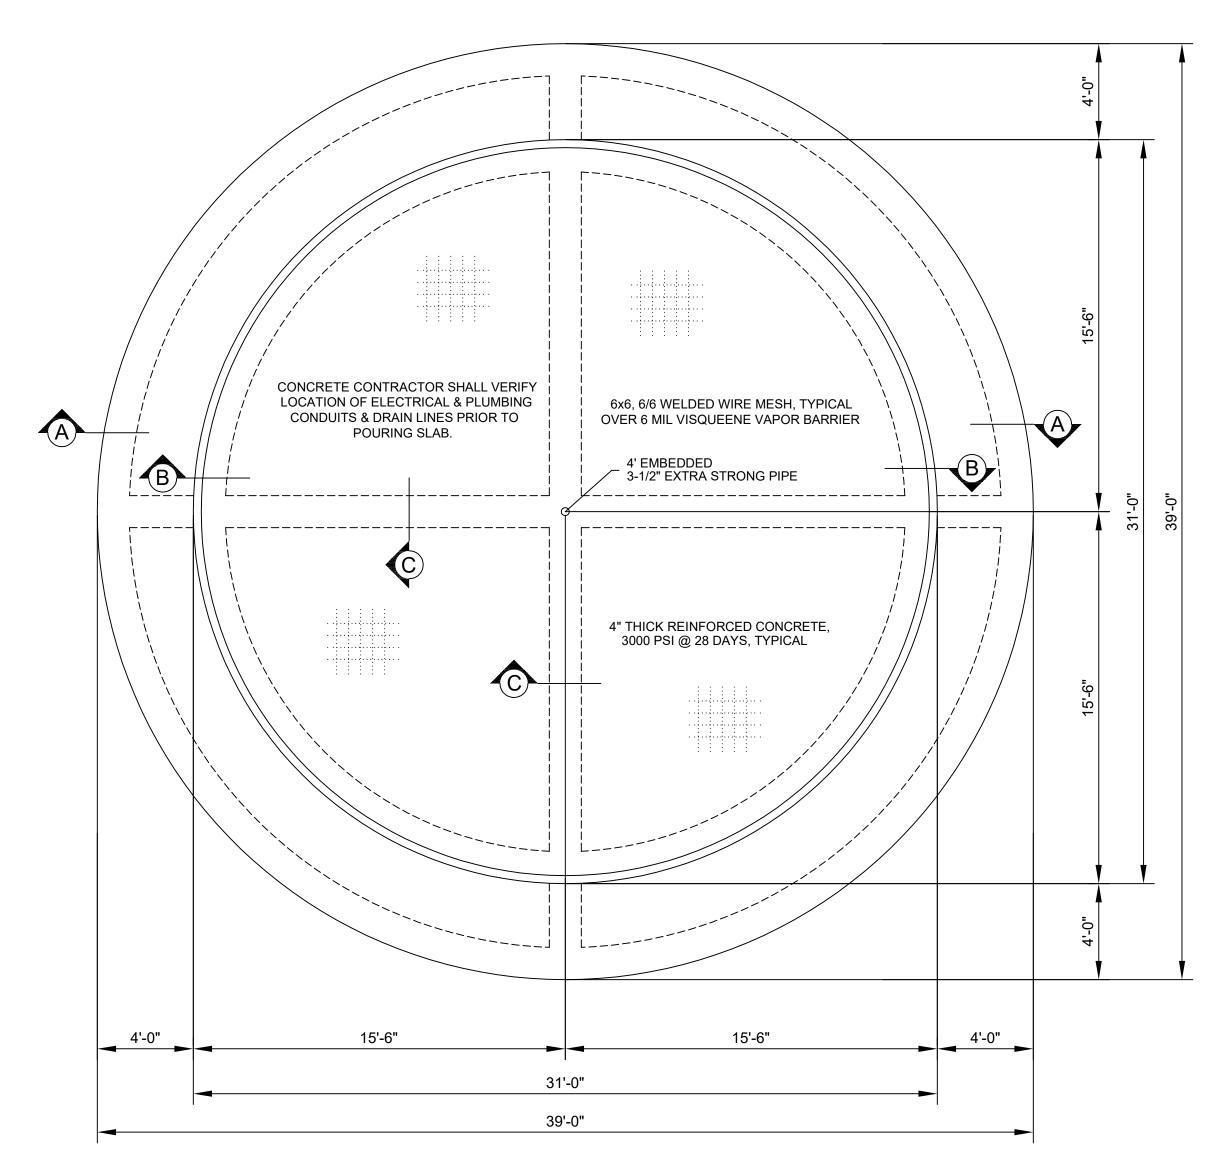

FOUNDATION PLAN

SCALE: 1/4"=1'-0"

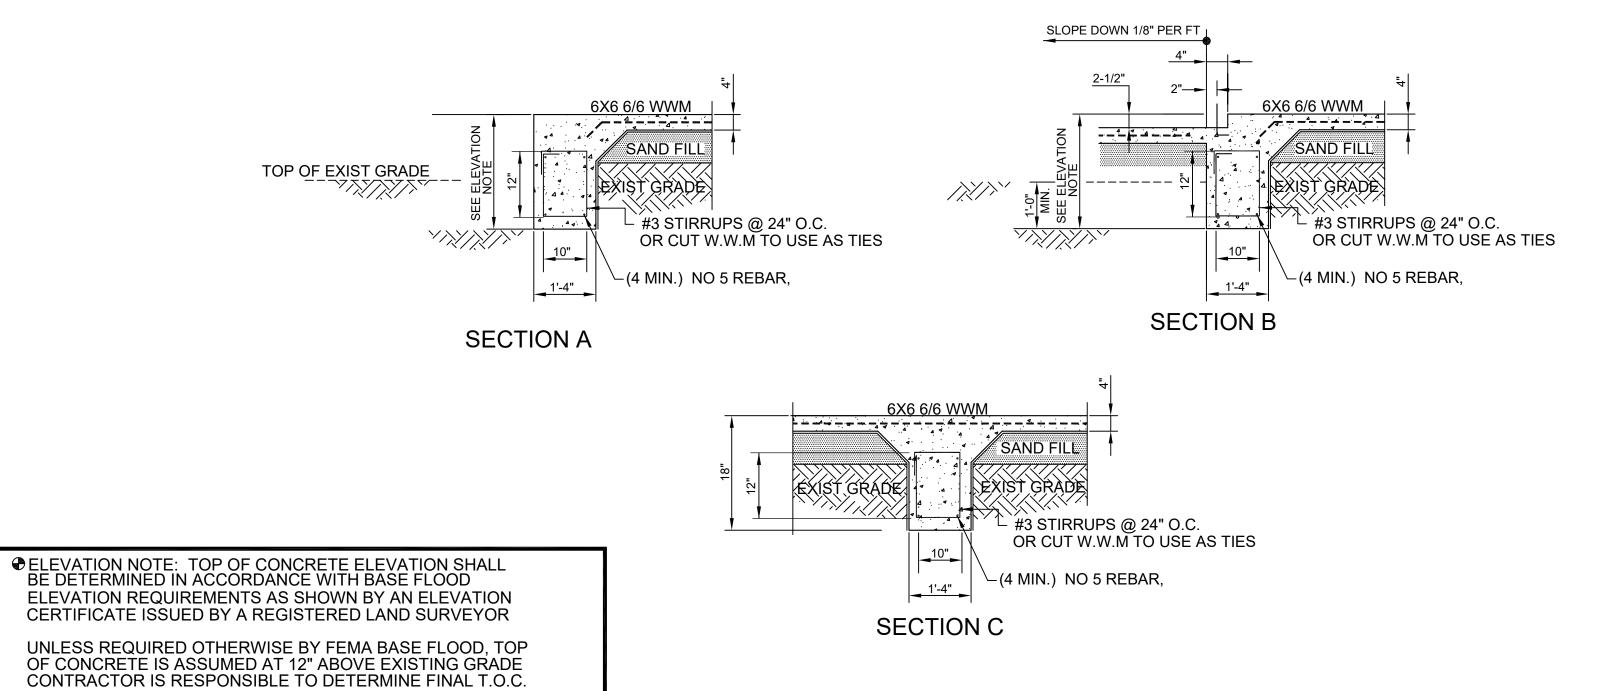

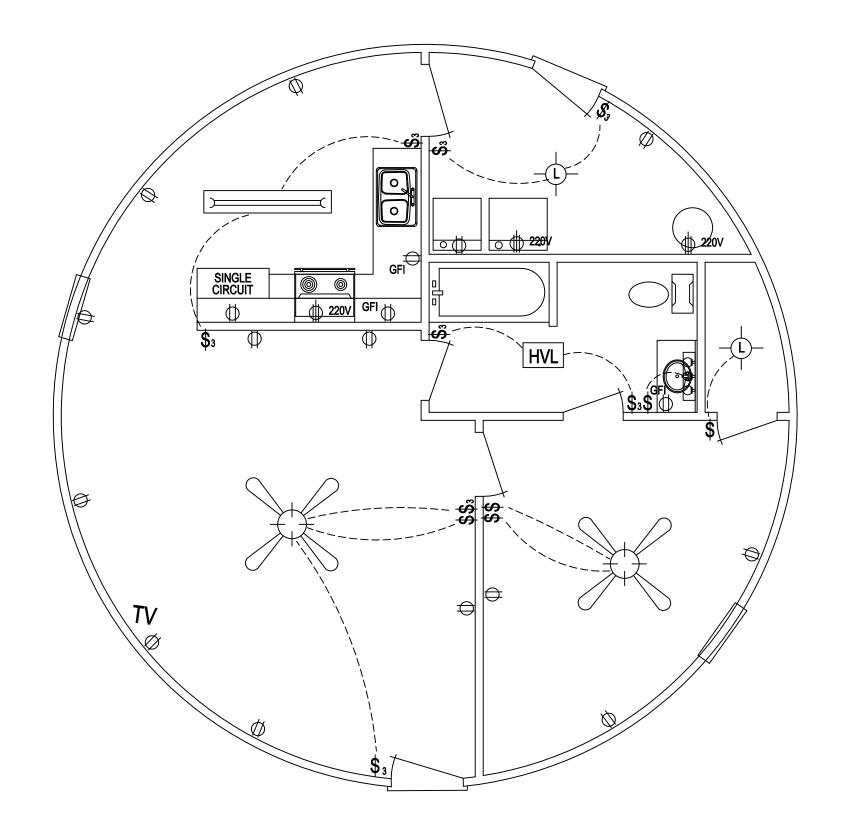

ELECTRICAL PLAN

1/4" = 1'-0"

ELECTRICAL LEGEND

110 V DUPLEX RECEPTACLE

220 V RECEPTACLE

110 V DUPLEX RECEPTACLE GROUND FAULT INSULATED CIRCUIT

110 V DUPLEX RECEPTACLE

WPGFI GROUND FAULT INSULATED CIRCUIT

SINGLE POLE SWITCH

THREE-WAY SWITCH

TELIVISION CABLE JACK

TELEPHONE JACK


DOOR BELL

FLUOR. LIGHT



AS PER OWNER

HVL HEATER /VENT / LIGHT

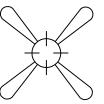

INSTALLED

CEILING FAN W/LIGHT

WALL FIXTURE OVER VANITY



ELECTRICAL

LOCATED IN ATTIC.

CODE REFERENCE:

IRC -NEC CROSS REFERENCE

ELECTRICAL CONTRACTOR

CONTRACTOR'S ADDRESS

CONTRACTOR'S PHONE:

2014 NATIONAL ELECTRIC CODE

CONTRACTOR'S LICENSE NUMBER

1. ELECTRICAL CONTRACTOR SHALL BE RESPONSIBLE FOR DETERMINING THE QUALITY AND CORRECT SIZE

2. LOCATION OF ELECTRIC METER & MAIN DISTRIBUTION

IN EFFECT AT TIME OF CONSTRUCTION.

AS PER LOCALLY ADOPTED BUILDING CODES.

OF ALL CIRCUITS AS WELL AS ALL OTHER ELECTRICAL COMPONENTS. ALL ELECTRICAL WORK SHALL MEET ALL

LOCAL AS WELL AS THE NATIONAL ELECTRICAL CODES

PANEL SHALL BE DETERMINED DURING CONSTRUCTION


3. ALL SMOKE DETECTORS ARE TO BE WIRED TO COME ON TOGETHER AND SHALL BE LOCATED PER IRC: R314.13


4. HEATER VENT LIGHTS ARE TO BE VENTED TO OUTSIDE.

5. PROVIDE NECCESSARY UTILITIES & LIGHTING FOR UNITS

6. ALL BEDROOMS SHALL HAVE AFI BREAKERS PER IRC E3902

7. ALL OUTLETS OVER KITCHEN COUNTERTOPS, BATHROOMS, UTILITY ROOMS, MUD ROOMS, AND OUTDOOR AREAS SHALL HAVE GROUND FAULT CIRCUIT INTERRUPT PROTECTION

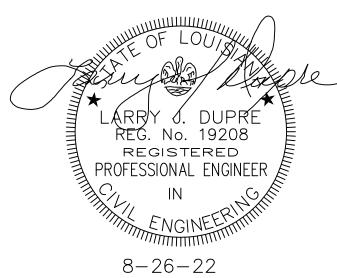

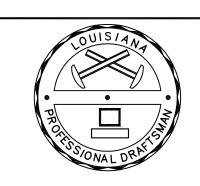

FOUNDATION PLAN ELECTRICAL PLAN

CANTER'S SERVICES LLC (985) 226-1804

1194 SQUARE FEET

LIVING AREA WALKWAY

444 SQUARE FEET

| 0 | 8-19-22 | | FOR CONSTRUCTION |
|-----|---------|----|------------------|
| REV | DATE | BY | DESCRIPTION |

REVISIONS

RESIDENCE FOR:

TELISA CLARK

134 MORRISON AVE. HOUMA, LA. 70364

1608-2 0 1/4" = 1'-0"

7-6-22